

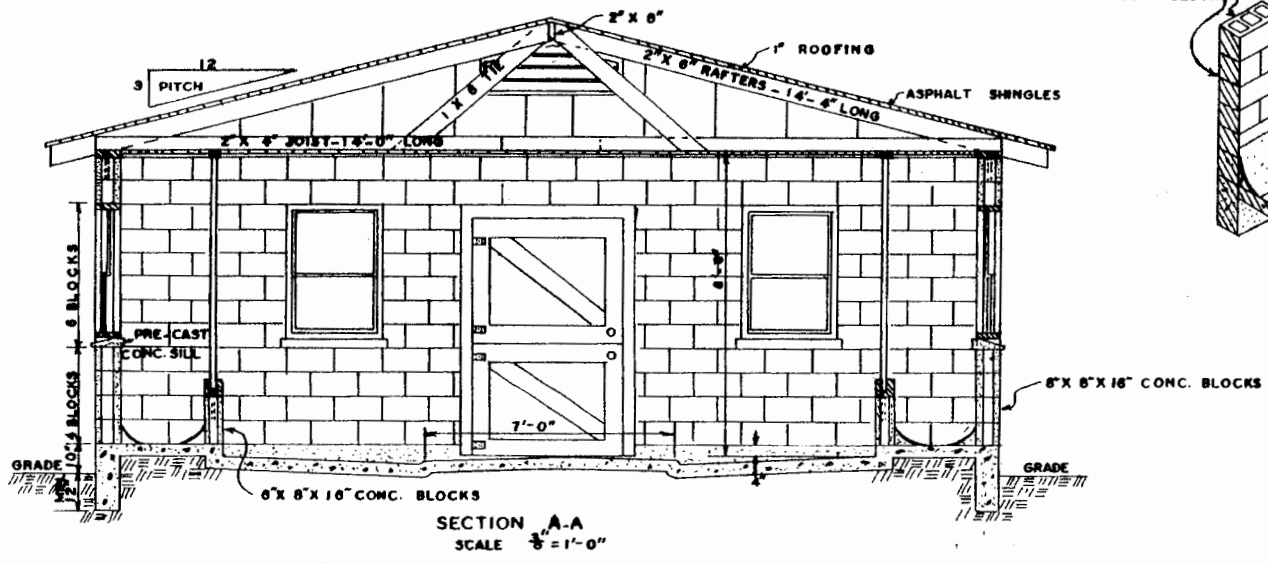



FLOOR PLAN SCALE $\frac{1}{4}'' = 1'-0''$

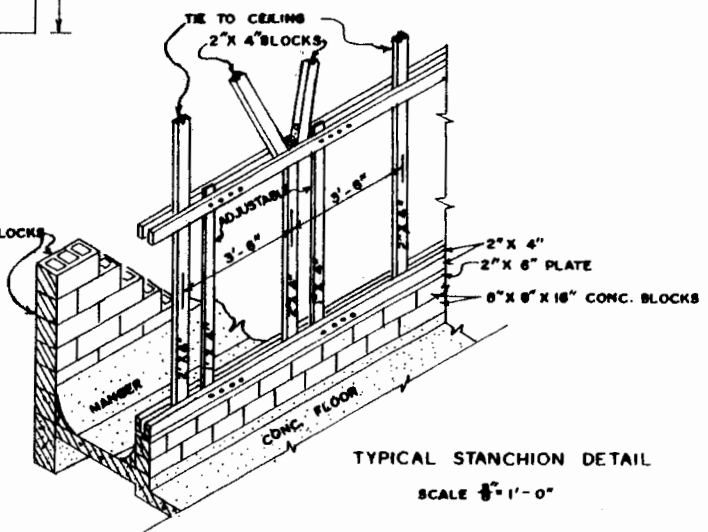


LSU AgCenter <small>RESEARCH & EXTENSION</small>	
11 COW DAIRY BARN	
ENGINEER C. E. S.	SCALE AS SHOWN
DRAWN BY H. B. M.	SHEET 1 OF 2
TRACED BY R. S. T.	DATE 2 62 NO. 30-6

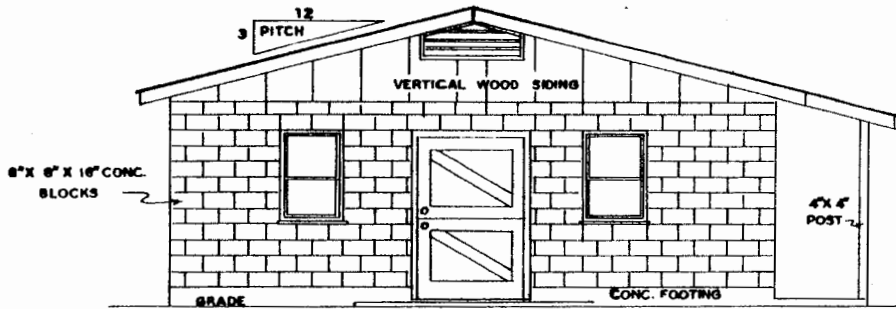


ELEVATION A

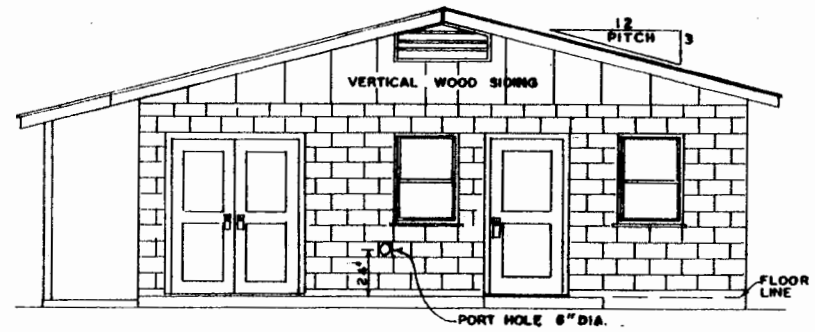

ELEVATION C

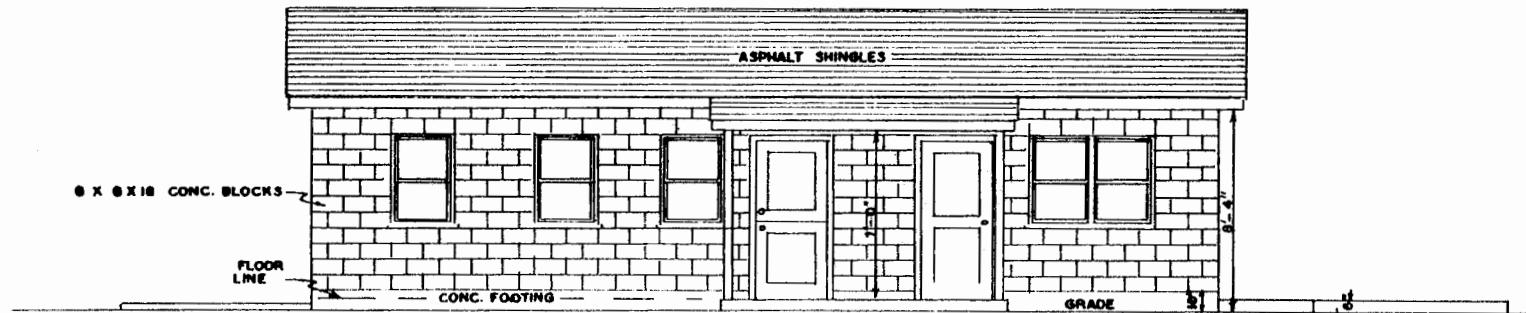


ELEVATION B

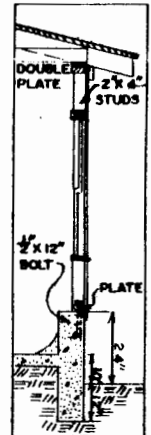

WALL SECTION
FRAME WALL
SCALE $\frac{1}{8}'' = 1' 0''$

NOTE: IF FRAME STRUCTURE IS
DESIRED A 24" CHAIN WALL
MUST BE USED.

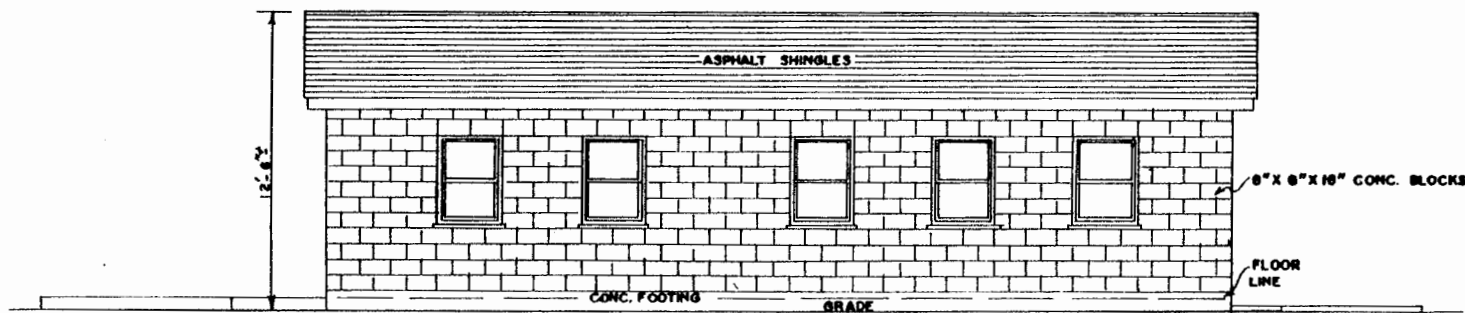

ELEVATION D



11 COW DAIRY BARN

ENGINEER C. E. S.	SCALE AS SHOWN
DRAWN BY H. B. M.	SHEET 2 OF 2
TRACED BY R. S. T.	DATE 2-1-62 NO. 30-6

Disclaimer

This site makes available conceptual plans that can be helpful in developing building layouts and selecting equipment for various agricultural applications. These plans do not necessarily represent the most current technology or construction codes. They are not construction plans and do not replace the need for competent design assistance in developing safe, legal and well-functioning agricultural building system. The LSU Agriculture Center, the Mid-West Plan Service, the United States Department of Agriculture and none of the cooperating land-grant universities warranty these plans.